



054616.003 ROCK STREET & 6TH STREET,

ROCK STREET & CAPITOL STREET INTERSECTION IMPROVEMENTS

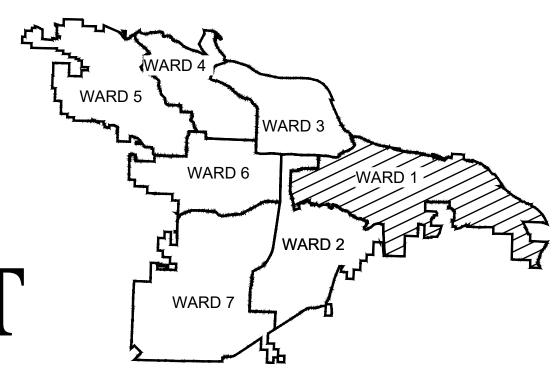

PROJECT LOCATION - WARD


15% SUBMITTAL

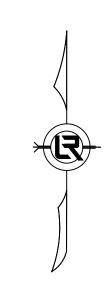

Disad Provided St. Section 5: Ward St. Ward St.	W Broadway St	E Broactway St S 70 S S S S S S S S S S S S S S S S S
Weinst Winst	VVCFto7	Provoent Cinton Ave 250 Dean Culturation PROJECT LOCATION Ave Capital Ave
With St. Wit	With St E 9th St E 9th St School With St E 9th St School With St E 9th St School MACARTHUR PARK E 10th St E 12th St E 13th	Egitiss Egi

Sheet List Table		
Sheet Number	Sheet Title	
C1	COVER SHEET	
C2	GENERAL NOTES	
C3	ROCK ST. & 6TH ST. SITE PLAN	
C4	ROCK ST. & E. CAPITOL AVE. SITE PLAN	


N.T.S.

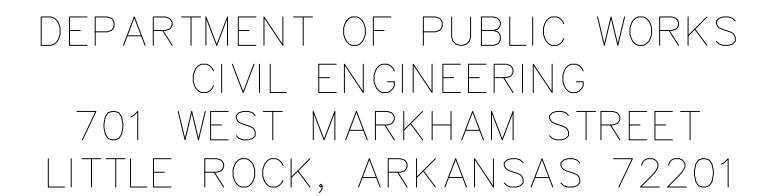



Main (501) 801-2679

REVISIONS

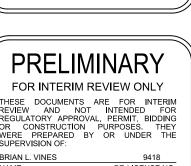

DRAWN BY TJL **DESIGNED** XXX CHECKED DATE

1470 FIRM / BUSINESS NO.

MAY 2024 SCALE **NO SCALE** PROJECT NO.

054616.003 SHEET NO.



GENERAL CONSTRUCTION NOTES

- 1. ALL WORK SHALL CONFORM TO THE REQUIREMENTS OF THE CITY OF LITTLE ROCK AND SHALL BE IN ACCORDANCE WITH THE CITY OF LITTLE ROCK STANDARD DETAILS AND SPECIFICATIONS FOR CONSTRUCTION. ALL WORK NOT COVERED IN THE CONTRACT DOCUMENTS AND THE CITY OF LITTLE ROCK STANDARD DETAILS AND SPECIFICATIONS FOR CONSTRUCTION SHALL BE GOVERNED BY THE ARKANSAS DEPARTMENT OF TRANSPORTATION STANDARD DETAILS AND SPECIFICATIONS FOR CONSTRUCTION, CURRENT EDITION.
- 2. EXISTING UTILITY LOCATIONS SHOWN ARE GENERALLY SCHEMATIC IN NATURE AND MAY NOT ACCURATELY REFLECT THE SIZE AND LOCATION OF EACH PARTICULAR UTILITY. EXISTING UTILITIES SHOWN HAVE BEEN BASED ON AVAILABLE RECORD DRAWINGS AND SURFACE APPURTENANCE FIELD TIES ONLY SOME UTILITY LINES AND SURFACE LOCATIONS MAY NOT BE SHOWN. THE CONTRACTOR SHALL ASSUME RESPONSIBILITY FOR ACTUAL FIELD LOCATION AND PROTECTION OF EXISTING UTILITIES WHETHER SHOWN OR NOT.THE CONTRACTOR SHALL ALSO ASSUME RESPONSIBILITY FOR REPAIRS TO EXISTING UTILITIES WHETHER SHOWN OR NOT, DAMAGED BY THE CONTRACTOR'S ACTIVITIES. DIFFERENCES IN HORIZONTAL OR VERTICAL LOCATION OF EXISTING UTILITIES SHALL NOT BE BASIS FOR ADDITIONAL COMPENSATION TO THE CONTRACTOR.
- BASIC HORIZONTAL AND VERTICAL CONTROL POINTS WILL BE ESTABLISHED OR DESIGNATED BY HALFF. THESE POINTS SHALL BE USED AS A DATUM FOR THE WORK. ALL ADDITIONAL SURVEY WORK SHALL BE PERFORMED BY A COMPETENT SURVEYOR EMPLOYED BY THE CONTRACTOR.
- 4. THE CONTRACTOR SHALL PROTECT EXISTING PROPERTY MONUMENTATION AND PRIMARY CONTROL. ANY SUCH POINTS WHICH THE CONTRACTOR BELIEVES WILL BE DESTROYED SHALL HAVE OFFSET POINTS ESTABLISHED BY THE CONTRACTOR PRIOR TO CONSTRUCTION. ANY MONUMENTATION DESTROYED BY THE CONTRACTOR SHALL BE REESTABLISHED AT CONTRACTOR'S EXPENSE BY A REGISTERED PROFESSIONAL LAND SURVEYOR.
- 5. IT SHALL BE THE RESPONSIBILITY OF THE CONTRACTOR TO: A.) PREVENT ANY DAMAGE TO PRIVATE PROPERTY AND PROPERTY OWNER'S POLES, FENCES, SHRUBS, ETC. B.) PROTECT ALL UNDERGROUND UTILITIES. C.) NOTIFY ALL UTILITY COMPANIES AT LEAST 48 HOURS PRIOR TO EXCAVATION D.) FIELD VERIFY HORIZONTAL AND VERTICAL LOCATION OF ALL UTILITIES IN THE VICINITY OF CONSTRUCTION ACTIVITIES PRIOR TO START OF CONSTRUCTION. THE CONTRACTOR SHALL NOTIFY ENGINEER OF ANY UNIDENTIFIED POTENTIAL CONFLICTS THAT MAY EXIST BETWEEN THE EXISTING UTILITIES AND CONSTRUCTION PLANS.
- 6. ANY DAMAGES THAT MAY OCCUR TO REAL PROPERTY OR EXISTING IMPROVEMENTS, INCLUDING EXISTING PRIVATE AND PUBLIC LANDSCAPE IRRIGATION SYSTEMS, SHALL BE RESTORED BY THE CONTRACTOR TO AT LEAST THE SAME CONDITION THAT THE REAL PROPERTY OR EXISTING IMPROVEMENTS WERE IN PRIOR TO THE DAMAGES. THIS RESTORATION SHALL BE SUBJECT TO THE OWNER'S APPROVAL; MOREOVER, THIS RESTORATION SHALL NOT BE A BASIS FOR ADDITIONAL COMPENSATION TO THE CONTRACTOR. THE CONTRACTOR MUST FURNISH A LETTER TO THE CITY OF LITTLE ROCK, SIGNED BY THE PROPERTY OWNER, WHICH STATES REPAIRS ARE SATISFACTORY.
- 7. THE CONTRACTOR SHALL LOCATE AND RECORD ANY EXISTING IRRIGATION SYSTEM PRIOR TO CONSTRUCTION. CONTRACTOR SHALL TEMPORARILY REMOVE AND CAP IRRIGATION SYSTEM AS NECESSARY FOR CONSTRUCTION AND SHALL REPLACE THE PORTIONS EQUIVALENT SYSTEMS. CONTRACTOR SHALL COORDINATE ANY IRRIGATION WORK WITH CITY AND PROPERTY OWNER'S REPRESENTATIVES.
- CONTRACTOR SHALL COORDINATE THE PROTECTION OF EXISTING FRANCHISE UTILITIES AND APPURTENANCES INCLUDING EXISTING UTILITY POLES IN THE VICINITY OF CONSTRUCTION OPERATIONS WHETHER UTILITIES ARE SHOWN ON THE CONTRACT DOCUMENTS OR NOT. ANY DAMAGE INCURRED TO EXISTING FRANCHISE UTILITIES, APPURTENANCES, UTILITY POLES, LIGHT STANDARDS, ETC., BY CONSTRUCTION RELATED ACTIVITIES SHALL BE THE SOLE RESPONSIBILITY OF THE CONTRACTOR.
- 9. THE CONTRACTOR SHALL MAINTAIN DRAINAGE AT ALL TIMES DURING CONSTRUCTION. PONDS OF WATER IN STREETS, DRIVES, TRENCHES, ETC. WILL NOT BE ALLOWED. THE CONTRACTOR SHALL MAINTAIN RESIDENTIAL DRIVEWAY ACCESS AT ALL TIMES.
- 10. THE CONTRACTOR SHALL MAINTAIN EXISTING SANITARY SEWER AND WATER SERVICE AT ALL TIMES DURING CONSTRUCTION.
- 11. THE CONTRACTOR IS RESPONSIBLE FOR COORDINATION WITH UTILITY COMPANIES AND ADJUSTMENT OF EXISTING SANITARY SEWER MANHOLES, CLEANOUTS, WATER METERS, WATER VALVES, FIRE HYDRANTS AND OTHER UTILITY APPURTENANCES TO FINISHED GRADE AS REQUIRED AT NO ADDITIONAL COST TO THE CITY OF LITTLE ROCK.
- 12. THE CONTRACTOR SHALL EXCAVATE AND FIELD LOCATE THE HORIZONTAL AND VERTICAL LOCATION OF EXISTING WATER LINES AND SANITARY SEWER LINES AT ALL PROPOSED STORM DRAIN LINE CROSSING LOCATIONS UTILIZING PROVIDED PROJECT CONTROL.IN ADDITION, THE HORIZONTAL AND VERTICAL LOCATION AND SIZE OF EXISTING STORM DRAIN LINES SHALL BE VERIFIED AT THE POINT OF PROPOSED CONNECTION WITH NEW STORM DRAIN FACILITIES. FIELD VERIFICATION SHALL BE PERFORMED BY THE CONTRACTOR PRIOR TO BEGINNING CONSTRUCTION OF THE PROPOSED STORM DRAIN IMPROVEMENTS. THE CONTRACTOR SHALL IMMEDIATELY NOTIFY THE ENGINEER OF ANY DISCREPANCIES IDENTIFIED BETWEEN THE CONTRACTOR'S FIELD VERIFIED OF EXISTING UTILITY LOCATION AND THE EXISTING UTILITY LOCATION REPRESENTED ON THE DRAWINGS. THE CONTRACTOR SHALL GIVE ALL FRANCHISE UTILITIES 48-HOUR ADVANCED NOTICE BEFORE CONSTRUCTION IN AREAS WHERE UTILITIES ARE PRESENT.
- 13. AREAS OF THE SITE THAT WILL UNDERLIE FILL SHALL BE SCARIFIED TO A DEPTH OF 6 INCHES AND RECOMPACTED TO A MINIMUM OF 95% OF THE MAXIMUM DENSITY, AS DETERMINED BY ASTM D698, "STANDARD PROCTOR". THE MOISTURE CONTENT SHALL RANGE FROM -2 TO +4 PERCENTAGE POINTS ABOVE OPTIMUM.
- 14. PEDESTRIAN AND VEHICULAR TRAFFIC FLOW, SAFETY AND ACCESS SHALL BE MAINTAINED DURING ALL PHASES OF CONSTRUCTION. BARRICADING AND TRAFFIC CONTROL DURING CONSTRUCTION SHALL BE THE RESPONSIBILITY OF THE CONTRACTOR AND SHALL CONFORM TO THE "MANUAL ON UNIFORM TRAFFIC CONTROL DEVICES", PART VI IN PARTICULAR. TRAFFIC FLOW AND ACCESS SHALL BE MAINTAINED DURING ALL PHASES OF CONSTRUCTION UNLESS OTHERWISE NOTED ON THE TRAFFIC CONTROL PLAN. THE CONTRACTOR IS RESPONSIBLE FOR PROVIDING TRAFFIC SAFETY MEASURES FOR WORK ON THE PROJECT. THE CONTRACTOR SHALL ASSUME FULL RESPONSIBILITY FOR PUBLIC SAFETY IN THE CONSTRUCTION AREA DURING THE DURATION OF CONSTRUCTION ACTIVITIES.
- 15. THE CONTRACTOR SHALL ABIDE BY ALL APPLICABLE FEDERAL, STATE, AND LOCAL LAWS GOVERNING EXCAVATION AND TRENCH SAFETY. THE CONTRACTOR SHALL PROVIDE DETAILED PLANS AND SPECIFICATIONS FOR EXCAVATION AND TRENCH SAFETY SYSTEMS THAT COMPLY WITH APPLICABLE LAWS GOVERNING EXCAVATION AND TRENCH SAFETY. THESE PLANS SHALL BE SEALED BY AN ENGINEER REGISTERED IN THE STATE OF ARKANSAS EXPERIENCED IN THE DESIGN OF EXCAVATION AND TRENCH SAFETY SYSTEMS. THE CONTRACTOR SHALL SUBMIT COMPLETED EXCAVATION AND TRENCH SAFETY PLAN TO THE ENGINEER PRIOR TO COMMENCING WORK. THE CONTRACTOR SHALL BE SOLELY RESPONSIBLE FOR ALL ASPECTS OF WORK RELATED TO EXCAVATION AND TRENCH SAFETY.

- CONTRACTOR SHALL REMOVE FROM THE PROJECT AREA ALL SURPLUS MATERIAL. THIS WORK SHALL BE INCIDENTAL AND NOT A SEPARATE PAY ITEM. SURPLUS MATERIALS FROM EXCAVATION INCLUDE DIRT, TRASH, ROCK MEASURING GREATER THAN 4 INCHES IN THE LARGEST DIMENSION, ETC. SHALL BE PROPERLY DISPOSED OF AT A SITE ACCEPTABLE TO THE CITY OF LITTLE ROCK IF WITHIN THE CITY LIMITS. IF THE LOCATION IS NOT WITHIN THE CITY LIMITS, THE CONTRACTOR SHALL PROVIDE A LETTER STATING SO. NO EXCESS EXCAVATED MATERIAL SHALL BE DEPOSITED IN LOW AREAS OR ALONG NATURAL DRAINAGE WAYS WITH OUT WRITTEN PERMISSION FROM THE AFFECTED PROPERTY OWNER AND THE CITY OF LITTLE ROCK. IF THE CONTRACTOR PLACES EXCESS MATERIAL IN THESE AREAS WITHOUT WRITTEN PERMISSION, HE WILL BE RESPONSIBLE FOR ALL DAMAGES RESULTING FROM SUCH FILL AND HE SHALL REMOVE THE MATERIAL AT HIS OWN COST.
- BIDDERS SHALL MAKE ANY INVESTIGATION OF EXISTING SUBSURFACE CONDITIONS AS DEEMED NECESSARY AT NO EXPENSE TO THE CITY OF LITTLE ROCK. NEITHER THE CITY OF LITTLE ROCK NOR THE ENGINEER WILL BE RESPONSIBLE IN ANY WAY FOR ADDITIONAL COMPENSATION FOR EXCAVATION WORK PERFORMED UNDER THIS CONTRACT DUE TO THE CONTRACTOR'S ASSUMPTIONS.
- THE CONTRACTOR WILL FURNISH TO THE CITY OF LITTLE ROCK THE NAME OF AN OSHA CERTIFIED COMPETENT PERSON TO BE ON THE PROJECT AT ALL TIMES.
- WHERE TREES, PLANTS, SHRUBBERY, ETC., ARE ADJACENT TO THE LINE OF WORK AND ARE NOT TO BE REMOVED OR REMOVED AND REPLACED. THE CONTRACTOR SHALL PROTECT SUCH TREES, PLANTS, SHRUBBERY, ETC. IF SUCH TREES, PLANTS SHRUBBERY, ETC., COULD LIKELY BE DAMAGED BY MACHINERY, ETC., ORANGE SAFETY FENCING WITH STEEL T-POSTS HAVING A MINIMUM HEIGHT OF 3 FEET AND AS APPROVED BY THE CITY SHALL BE UTILIZED FOR PROTECTION. HAND EXCAVATION MAY ALSO BE REQUIRED IN VICINITY OF TREES, PLANTS, SHRUBBERY, ETC., THAT ARE TO REMAIN. THE CONTRACTOR SHALL NOT PERMIT MACHINERY OR EMPLOYEES TO SCRAPE, TEAR THE LIMBS FROM, DAMAGE OR ATTACH GUY CABLES TO EXISTING TREES THAT ARE TO REMAIN IN PLACE. THE CONTRACTOR SHALL BE RESPONSIBLE FOR ALL DAMAGES TO ADJACENT TREES, PLANTS, SHRUBBERY, ETC., THAT ARE TO REMAIN AND ANY SUCH DAMAGE SHALL BE REMEDIED TO THE SATISFACTION OF THE CITY. THE COSTS OF SUCH PROTECTION SHALL NOT BE PAID FOR DIRECTLY BUT SHALL BE CONSIDERED SUBSIDIARY TO ROW PREPARATION.
- CONTRACTOR SHALL COORDINATE WITH THE POSTMASTER AND OCCUPANTS ALONG THE PROPOSED IMPROVEMENTS TO SET UP POST OFFICE BOXES AND STOP MAIL DELIVERY DURING CONSTRUCTION (AS REQUIRED).
- BEFORE BEGINNING CONSTRUCTION, THE CONTRACTOR SHALL PREPARE A CONSTRUCTION SEQUENCE SCHEDULE. THE SCHEDULE SHALL BE SUCH THAT THERE IS A MINIMUM OF INTERFERENCE WITH TRAFFIC ALONG OR ADJACENT TO PROJECT.
- 22. CONSTRUCTION MAY NOT BEGIN EARLIER THAN 7:00 AM NOR CONTINUE AFTER 7:00 PM ON WEEKDAYS. CONSTRUCTION ON SATURDAY MAY NOT BEGIN BEFORE 8:00 AM NOR CONTINUE AFTER 3:00 PM AND WORK ON SUNDAY IS PROHIBITED UNLESS APPROVAL IS OBTAINED FROM THE CITY OF LITTLE ROCK.
- WORK MAY NOT BE BACKFILLED OR COVERED UNTIL INSPECTED BY THE CITY'S INSPECTOR.
- 24. THE LRSD SHALL EMPLOY AND PAY FOR THE SERVICES OF AN INDEPENDENT TESTING LABORATORY TO PERFORM ON SITE MATERIAL TESTS, INSPECTIONS, AND APPROVAL REQUIRED BY THE CONTRACT DOCUMENTS, LAWS, OR REGULATIONS OF CITY. HYDROSTATIC TESTS AND STERILIZATION OF WATER MAINS COMPLETED UNDER THIS CONTRACT WILL BE THE RESPONSIBILITY OF AND PAID FOR BY THE CONTRACTOR. AIR TESTS, DEFLECTIONS TESTS, AND VIDEO OF NEWLY CONSTRUCTED WASTEWATER MAINS AND VACUUM TESTS OF MANHOLES CONSTRUCTED UNDER THIS CONTRACT WILL BE THE RESPONSIBILITY OF AND PAID FOR BY THE CONTRACTOR. ALL COSTS ASSOCIATED WITH TESTING REQUIRED BY THE CONTRACTOR SHALL BE CONSIDERED TO BE INCLUDED WITH THE VARIOUS BID ITEMS. FAILED TESTS PERFORMED SHALL BE PAID FOR BY THE CONTRACTOR AS A DEDUCTION ITEM.
- 25. CONTRACTOR IS RESPONSIBLE TO PREPARE AND MAINTAIN THE STORM WATER POLLUTION PREVENTION PLAN AND SHALL KEEP A COPY OF THE PLAN ON-SITE AT ALL TIMES. CONTRACTOR SHALL SUBMIT A NOTICE OF INTENT (NOI) AND A NOTICE OF TERMINATION (NOT) TO (WHO?). TEMPORARY EROSION CONTROL SHALL BE USED TO MINIMIZE THE SPREAD OF SILT AND MUD FROM THE PROJECT ON EXISTING, DRAINAGE WAYS AND PUBLIC AND PRIVATE PROPERTY. CONTRACTOR SHALL INSTALL AND MAINTAIN EROSION CONTROL BEST MANAGEMENT PRACTICES (BMP'S) DEVICES; CONDUCTION AND DOCUMENTING INSPECTIONS OF BMP DEVICES. TEMPORARY EROSION CONTROLS BMP DEVICES MAY INCLUDE SILT FENCE, BERMS, DIKES, SWALES, STRIPS OF UNDISTURBED VEGETATION, CHECK DAMS AND OTHER METHODS AS REQUIRED BY THE ENGINEER OR HIS REPRESENTATIVE.
- 26. FINISHED SLOPES ON PUBLIC RIGHTS-OF-WAY AND EASEMENTS SHALL NOT BE STEEPER THAN 4:1, UNLESS OTHERWISE SPECIFIED.
- THE CONTRACTOR SHALL PROVIDE TRAFFIC CONTROL FOR REVIEW AND REFER TO PLANS FOR SUGGESTED TRAFFIC CONTROL AND CONSTRUCTION PHASING.
- 28. THE CONTRACTOR SHALL REMOVE, SALVAGE AND REPLACE ALL STREET AND TRAFFIC CONTROL SIGNS WHICH MAY BE DAMAGED BY CONSTRUCTION OF THE PROJECT. IF SIGNS ARE SHOWN TO BE REMOVED AND RELOCATED. IT SHALL BE THE RESPONSIBILITY OF THE CONTRACTOR TO PROTECT THE SIGNS BETWEEN REMOVAL AND REINSTALLATION.
- 29. CONTRACTOR SHALL COORDINATE WITH FRANCHISE UTILITY COMPANIES TO REMOVE OR RELOCATE AS REQUIRED, AT THE FRANCHISE UTILITY OWNERS' EXPENSE WHEN APPLICABLE.

30. THE CONTRACTOR SHALL SUPPLY WATER FOR CONSTRUCTION.

LEGEND

EXISTING	3	PROPOSED	100
ipou pon	0.00	CONTOUR	1000
IRON ROD	O IR	SPOT ELEVATION	(25.180)
PK NAIL	O PK O RR(Sp)	SPOT CURB ELEVATION	(25.50)
R.R. SPIKE CONC. MONUMENT	□ CM	STORM SEWER - PIPE	G23,550
WATER VALVE	× wv	STORM SEWER - MITTERED END SECTION	_
WATER METER	III WM	STORM SEWER - GRATE INLET	_
FIRE HYDRANT	17 934		@ IDI
GAS METER	G OM	STORM SEWER - JUNCTION BOX	ושרש
GAS VALVE	⊎ GV	STORM SEWER - FLARED END SECTION	
CLEAN-OUT	0.00	STORM SEWER - HEADWALL	~
GUARD POST (BOLLARD)	* 10°	STORM SEWER - INLEY WITH SINGLE EXTENSION	
SIGN POST	-		3.000
BENCHMARK	4	STORM SOMER - INLET WITH DOUBLE EXTENSION	dDp
STORM SEWER MANHOLE	(0)	STORM SEWER - AREA INLET	D
SANITARY SEWER MANHOLE	(5)	GRADE BREAK LINE -	
		HIGH POINT	HP
TELEPHONE MANHOLE	(1)	LOW POINT	1,19
		CUT LINE -	- c -
ELECTRIC MANHOLE	(2)	PICL CINE -	- r -
TO COLLANS DAY		SANITARY SEWER PIPE	
TELEPHONE BOX ELECTRIC BOX		SANITARY SEWER MANHOLE	(3)
CABLE BOX	100	CURB	
UTILITY POLE	73.	DESCRIPTION OF THE PROPERTY OF	
GUY WIRE	=	CONCRETE	STEEDIS
LIGHT POLE	o	CONSTRUCTION - ENTRANCE/EXIT	(00)
POST OR POLE (TYPE AS NOTED)		OFECK DAW	380888888888
MAILBOX	810		-
	ON.	DIVERSION NERM	-
DECIDUOUS TREE	65	DOWNGRAIN STRUCTURE - TEMPORARY	ON
	MD.	MOCK DAM	(RD)
EVERGREEN/CONIFEROUS TREE	7.7	SEDIMENT BARBLER - SILT FENCE	(SD)
eur.	(C)	SEDIMENT BARRIER - GRAVEL RING	(SD2)
BUSH	(L)	SEDIMENT BANNIER - BLOCK & GRAVEL	(503)
PROPERTY LINE -		SEDIMENT BARRIER - BLOCK	(504)
SETBACK LINE		TEMPOHARY SEDIMENT BASIN	(SB1)
EASEMENT LINE		SLT FENCE - TYPE A	(SFA)
CURB		SET FENCE - TYPE B	(SFB)
FENCE		SET FENCE - TYPE C	(SFC)
		SET FENCE - TYPE C STORM DRAIN OUTLET PROTECTION SURFACE ROUGHENING DISTURBED AREA STABILIZATION -TEMPORARY STABILIZATIO	(SI)
		SURFACE ROUGHENING	(SI)
	dc	Distription and Stage (74 Note - Thattenance Stage (74 No.	Ow [TS1]
UNDERGROUND TELEPHONE	MET		(76-5)
#160 F.H.M. (1960 H.M. 1970 H.M. 1970	int -	DISTURBED AREA STABILIZATION -TEMPORARY GRASSING	TS2
UNDERGROUND CABLE		DISTURBED AREA STABLIZATION -PERMANENT GRASSING	15.3
MANAGER 201 (1989)	876	MATTING/BLANKETS	Mb
	#35		
GAS LINE	za" cue/ace/or		
STORM SEWER/CULVERT			
CONTOUR LINE	#B0		

QUANTITIES

Description	Unit	QUAN.
SITE PREPARATION	LS	1
UNCLASSIFIED EXCAVATION	CY	137
TOPSOIL	CY	18
AGGREGATE BASE COURSE	TON	4.89
TACK COAT	GAL	0.3
ACHM SURFACE COURSE	TON	2.64
ACHM BINDER COURSE	TON	2.64
CONCRETE CURBAND GUTTER (CLASS 3)	lF	640
CURBINLET - 4' BOX	EA	2
REINFORCED CONCRETE	CY	175
STORM DRAIN PIPE, 18" RCP	lF	17
TIE INTO EXISTING CONCRETE PIPE	EA	1
SOLID SODDING, BERMUDA	SY	55
ACCESS RAMP	F	592
FINALCLEANUP	LS	1
CLEANUP	LS	1
CONSTRUCTION ENTRANCE (CO)	EA	1
RELOCATE EXISTING SIGN	EA	3
Concrete Flume	SF	132
Trench Grates	SF	66


REVISIONS

NS

O


C


S

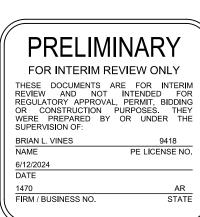

DRAWN BY TJL **DESIGNED** XXX CHECKED BLV DATE **MAY 2024** SCALE **NO SCALE** PROJECT NO. 054616.003

SHEET NO.

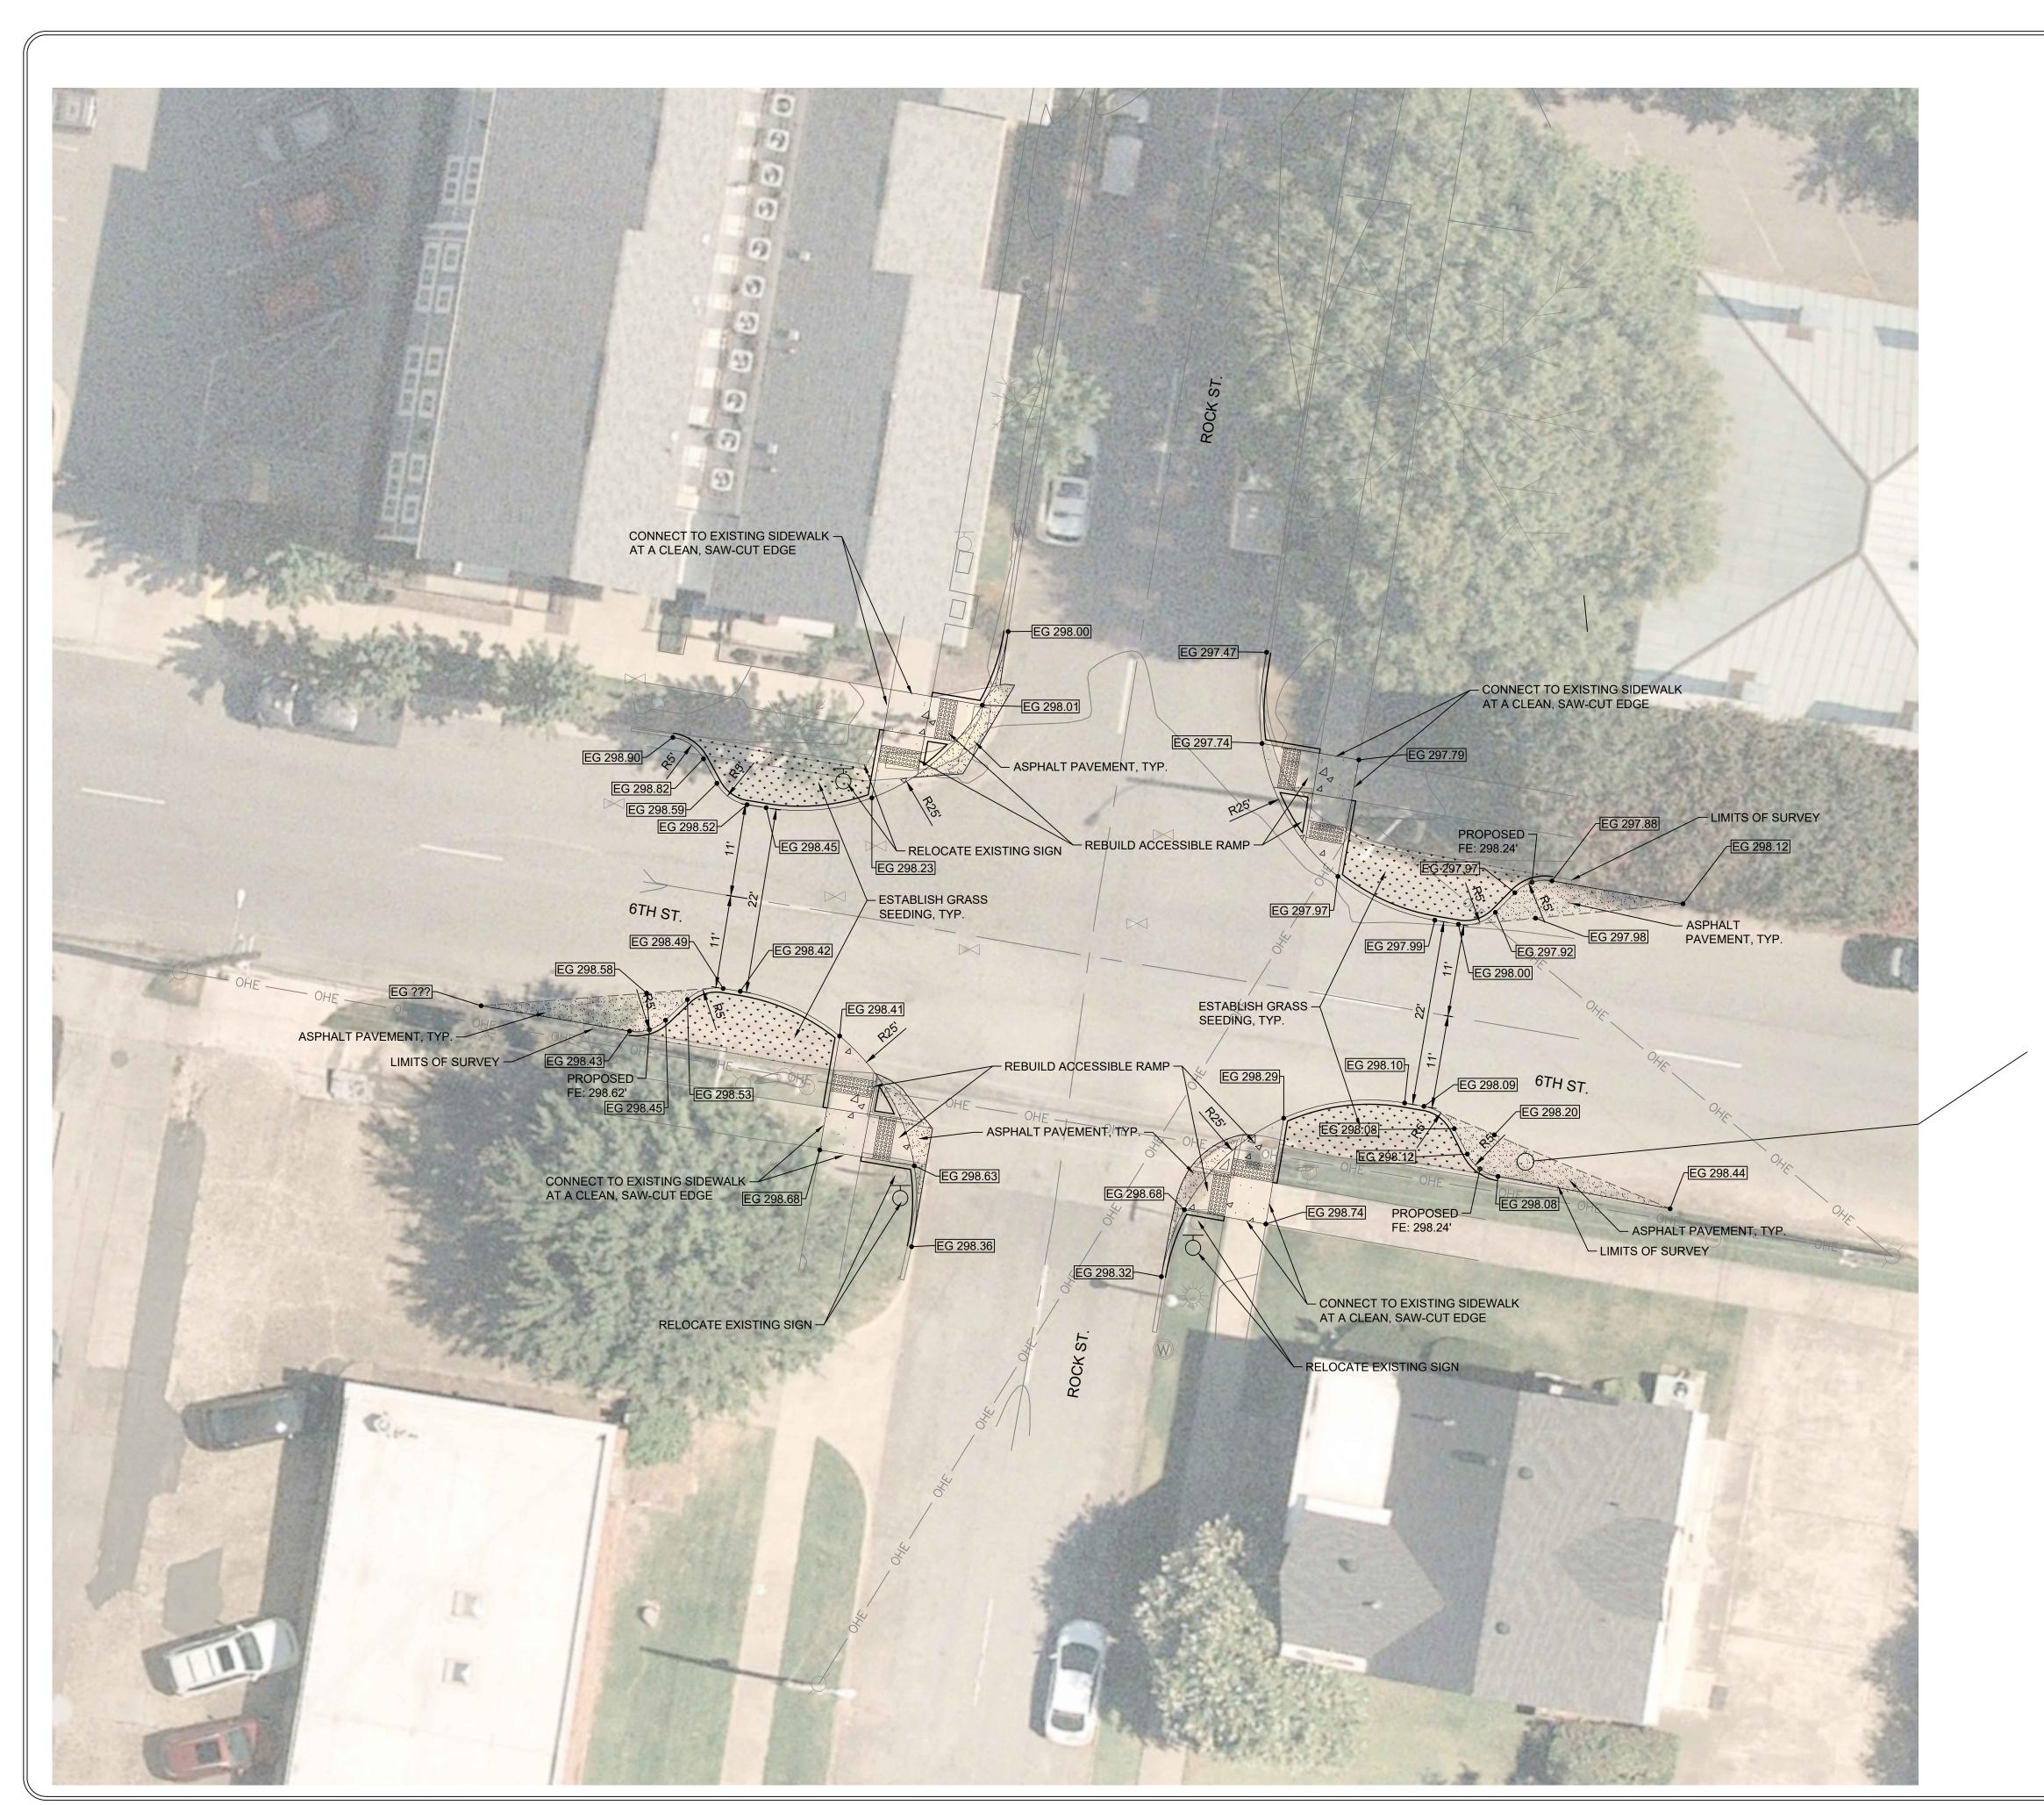

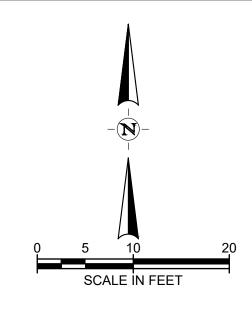

-3" ASPHALT, (1.5" SURFACE, 1.5" BINDER) 9" CRUSHED AGGREGATE BASE COURSE, CL.7 -8" (MIN) COMPACTED SUBGRADE TO 95% STANDARD PROCTOR DENSITY.

TYPICAL PAVING SECTION

ARKANSAS INTERSECTION ROCK, APITOL OF CITY 6ТН ROCK,


REVISIONS DATE


PRELIMINARY FOR INTERIM REVIEW ONLY 1470 FIRM / BUSINESS NO.

DRAWN BY TJL DESIGNED XXX CHECKED BLV DATE **MAY 2024 SCALE** 1"=10'

PROJECT NO. 054616.003 SHEET NO.



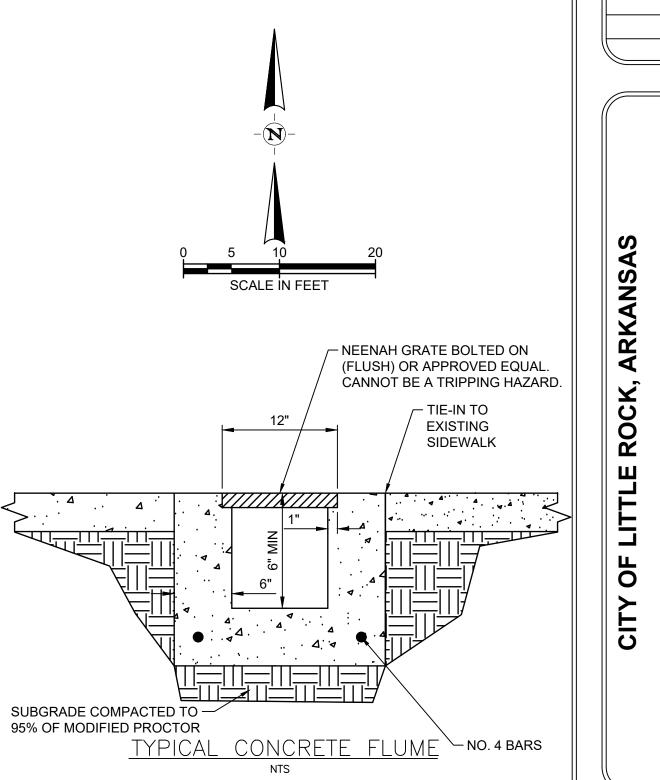

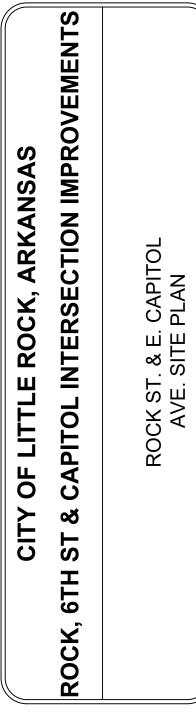

REVISIONS DATE

DEPARTMENT OF STATE O

PREL	_IMINARY
FOR INTE	RIM REVIEW ONLY
REVIEW AND REGULATORY A OR CONSTRUC	ENTS ARE FOR INTERII NOT INTENDED FOI PPROVAL, PERMIT, BIDDINIC CTION PURPOSES. THE ED BY OR UNDER THI
BRIAN L. VINES	9418
NAME	PE LICENSE NO
6/12/2024	
DATE	
1470	AR
	NO. STATI

DRAWN BY
TJL
DESIGNED
XXX
CHECKED
BLV
DATE
MAY 2024
SCALE
1"=10'
PROJECT NO.
054616.003

SHEET NO.